### CONSTRUCTION COPY



SHEATHING EDGE YCHES TABLE REO(23 (I)
8d COMMON (2 V2\* X OBT) NAL (SUBFLOOR)
8d COMMON (2 V2\* X OBT) NAL (ROOT)
TABLE REO(23 (3)
8d COMMON (2 V2\* X OBT) NAL (WALL)
(STUD SPACING (4\* OBT) NAL (WALL) TABLE R602,10.4 METHOD GB - GYPSUM BOARD NAILS OR SCREWS @ 7" O/C ALL PANEL EDGES FRAMING TRUSS TO PLATE, TOE NAIL
3 -16d BOX NAILS (3 1/2" X 0.135") OR
3 10d COMMON (3" X 0.146")

ALL OTHER CONNECTIONS, REFER TO 2015 IRC, TABLE R6023(I)
OR TO MANUFACTURER'S LITERATURE FOR REQUIRED FASTENERS

FRONT ELEVATION

SCALE: 1/4" = 1-0"

CODE: 2018 CONNECTICUT STATE BULDING CODE INCLUDING 2015 INTERNATIONAL RESPENTIAL CODE WALL BRACING METHOD:

R60210.4 CONTINUOUS SHEATHING CS-WSP (CONTINUOUS SHEATHING - WOOD STRUCTURAL PANEL)

ENERGY EFFICIENCY

MIDCA! BULDING THEM ALE THE BULDING THERMAL ENVELOPE SHALL BE DARBLET SEALED TO LIMIT INCLIDER FOR 16 AREAS IMPORTANT. REPER TO ENERGY CODE FOR 16 AREAS IMPORTANT. REPER TO ENTER SHALL BE CODUCTED WITH A BLOWER DOOR AT A PRESSURE OF 02 NICHES WAS GO PASCALS), AR LEAKAGE NOT TO EXCEED 3 AR CHANGE FOR NAME.

WIND SPEED:

ULTIMATE DESIGN WIND SPEED 135 MPH

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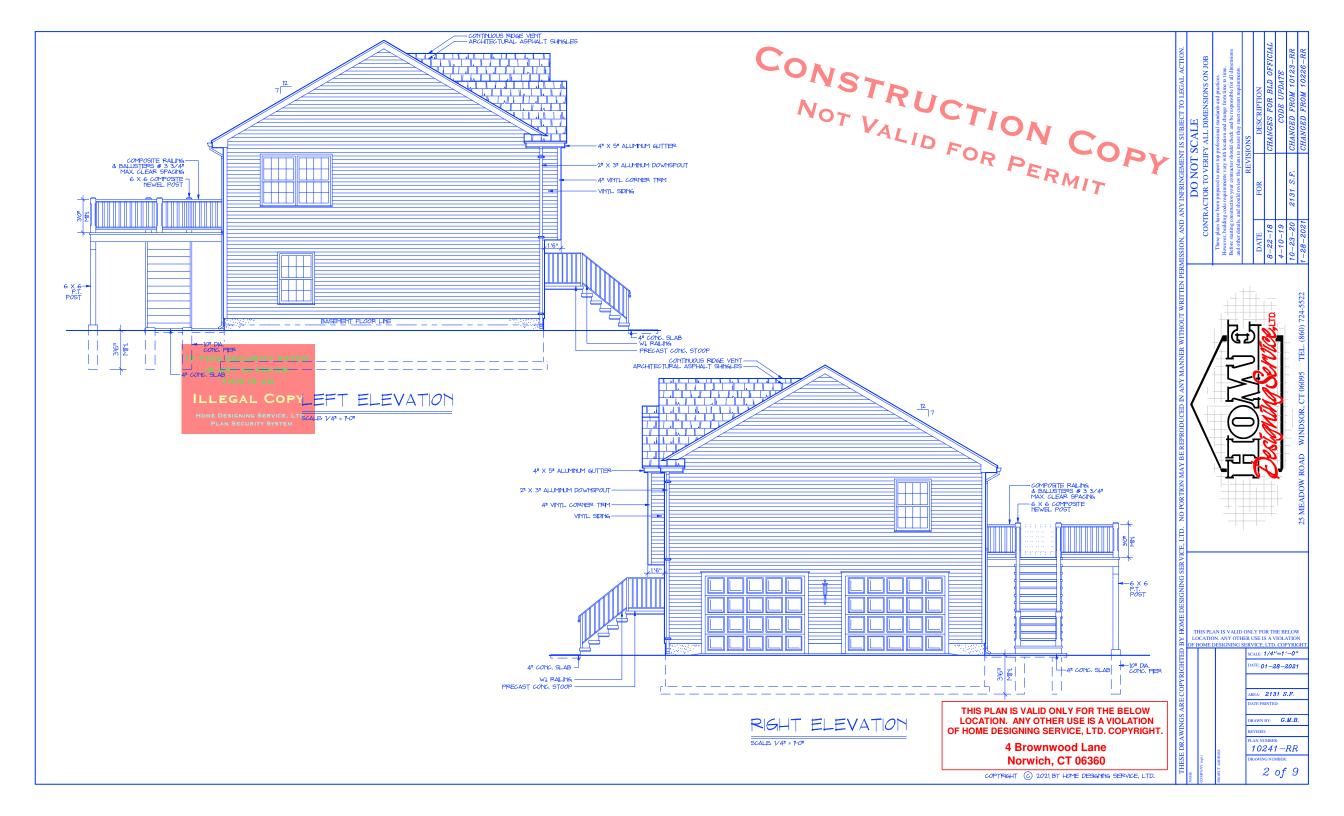
LE: 1/4"=1'-0" TE: 01-28-2021


AREA: 2131 S.F.


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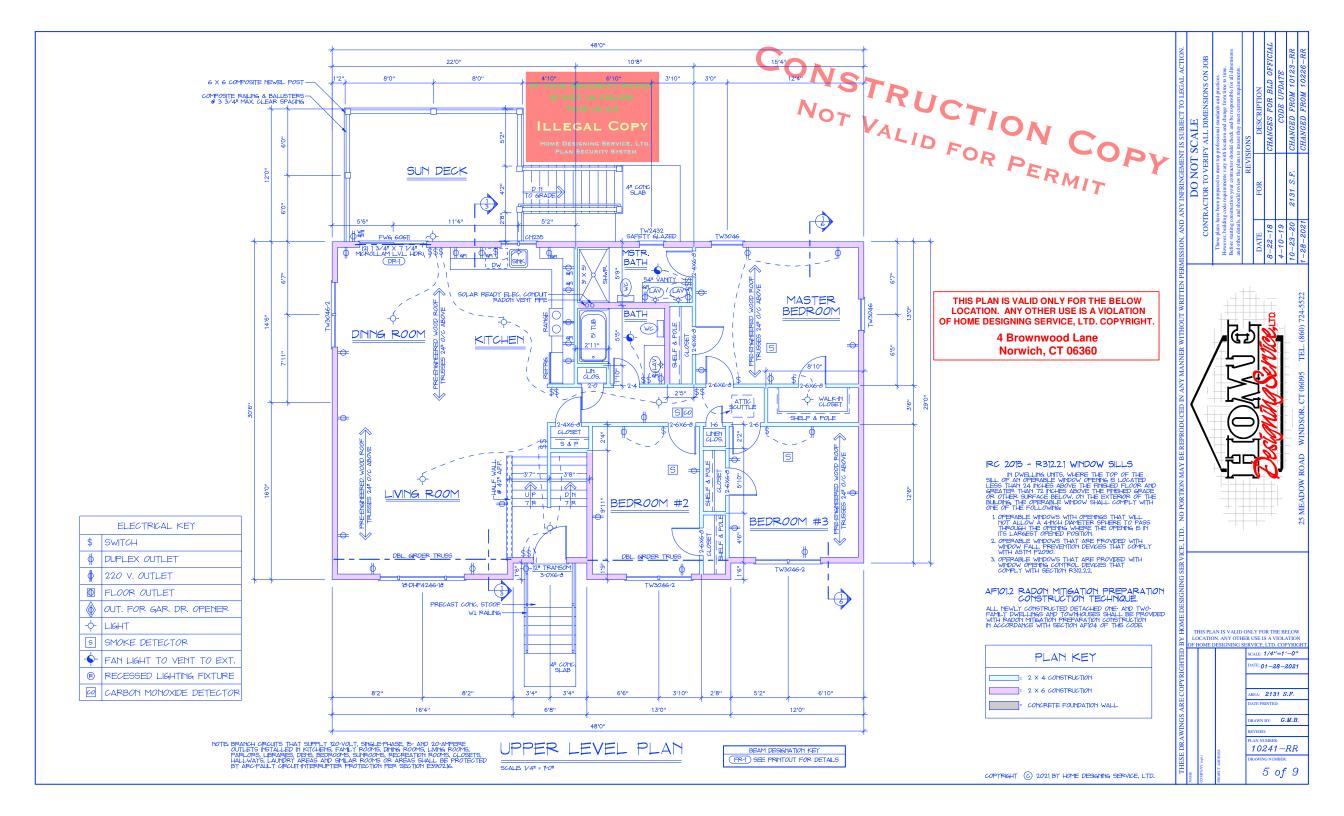
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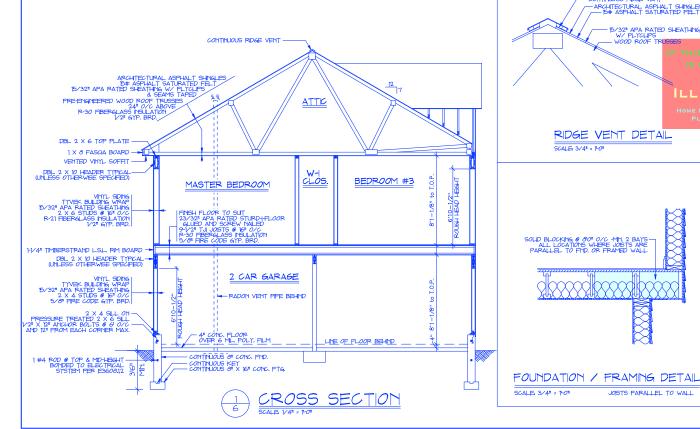




NOTE: ALL WINDOWS ARE DESIGNATED WITH ANDERSEN 400 SERIES MODEL NUMBERS SEE IMPORTANT NOTE ON FLOOR PLAN REGARDING WINDOW FALL PREVENTION DEVICES.

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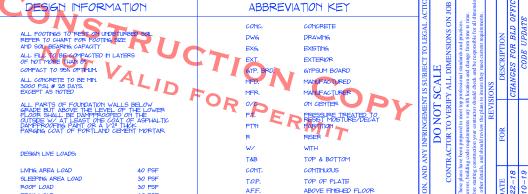

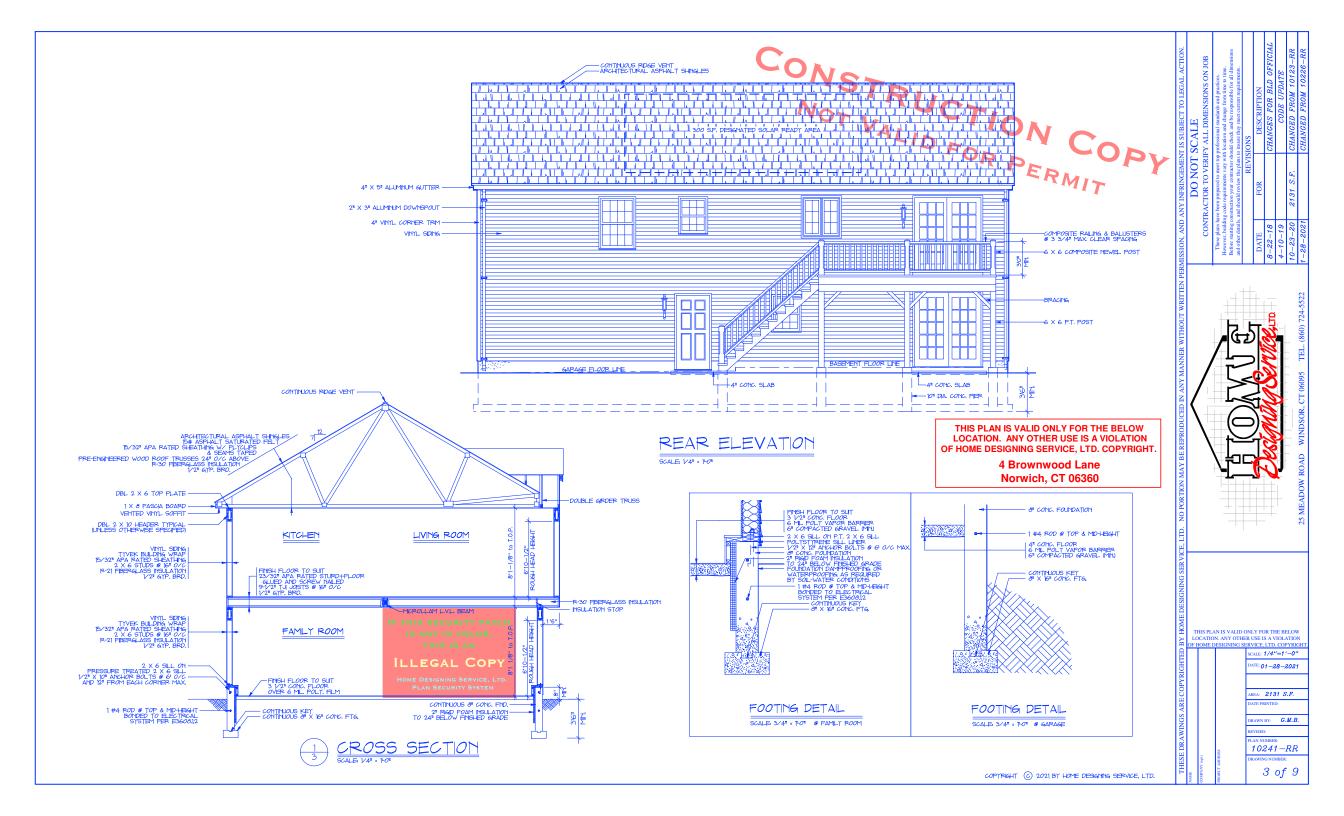
### FRAMING SPECIFICATION

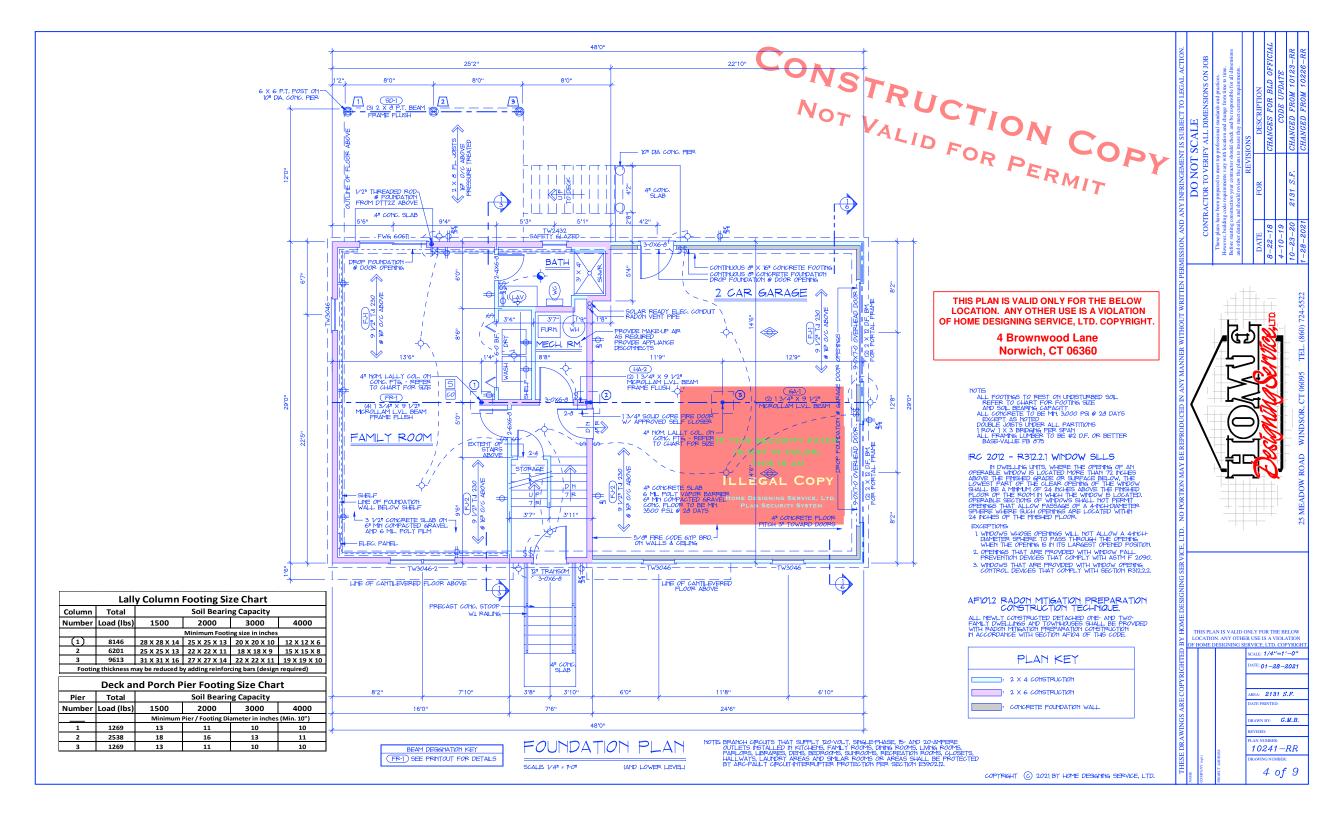- ALL FRAMING LUMBER SHALL BE DOUGLAS FIR OF THE FOLLOWING
- 2 X 4 STUDS- STANDARD & BETTER
  JSTS-BEAMS/2 X 6 STUDS-NO. 2 & BETTER
  #2 DF. BASE-VALUE FB 675 E = 1600,000
- 2. APPROVED NATURALLY DURABLE OR PRESSURE PRESERVATIVELY TREATED WOOD SHALL BE USED FOR THOSE PORTIONS OF WOOD MPDERS THAT FORM THE STRUCTURAL SUPPORTS OF BULDINGS BALCONES, PORCHES OR SMLAR PERMANENT BULDING APPRINTENANCES WHEN SUCH MPDERS ARE EXPOSED TO THE WEATHER WITHOUT ADEQUATE PROTECTION FROM A ROOF, EAVE, OVERHAING OR OTHER COVERNIG THAT WOLLD PREVENT MOSTURE OR WATER ACCUMULATION ON THE SURFACE OR AT JOINTS BETWEEN MEMBERS. SUCH MEMBERS SHALL INCLUDE:
- A HORIZONTAL MEMBERS SUCH AS GIRDERS, JOISTS AND DECKING. B. VERTICAL MEMBERS SUCH AS POSTS, POLES AND COLLIMINS. C. BOTH HORIZONTAL AND VERTICAL MEMBERS.
- ALL NAILS SHALL BE HOT-DIPPED GALV. WHERE EXPOSED TO EXTERIOR.
- 4. DOUBLE JOISTS UNDER ALL PARTITIONS.
- 5. THERE SHALL BE NO NAILING INTO END GRAIN END CONNECTORS SHALL BE MADE W/ 16 GA. GALV. MTL. CONNECTORS, JOIST HANGERS, ETC.

DESIGN INFORMATION

LIVING AREA LOAD	40 PSF
SLEEPING AREA LOAD	30 PSF
ROOF LOAD	30 PSF
DECK LOAD	40 PSF
EVTERIOR BALCONY LOAD	60 PGE



FINISHED HEAD HEIGHT

PRE-ENGINEERED ROOF TRUSSES @ 24" 0/6

R-30 FIBERGLASS INSULATION

V2" GYP. BPD.


MSULATION STOP


METAL TRUSS PLATE

ARCHITECTURAL ASPHALT SHINGLES

— 15# ASPHALT SATURATED FELT

—— 15/32# APA RATED SHEATHING W/ PLYCLIPS

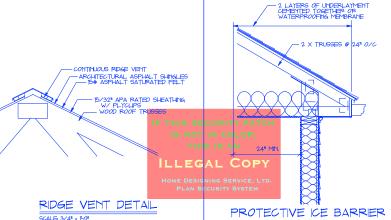

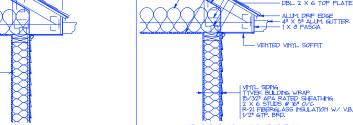

FHH.


### SCALE: 3/4" = 11-0"

FOUNDATION / FRAMING DETAIL


SCALE: 3/4" = 1-0"



SCALE: 3/4" = 1-0"

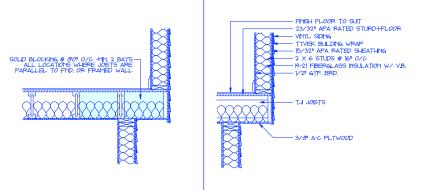

JOISTS PARALLEL TO WALL

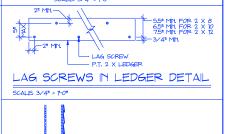



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LEDGER BOARD FLASHING		SCALE: 1/4"=1'-0"
1/2" DIA LAG SCREW @ 15" 0/C	RIGHTE	DATE: 01-28-2021
	COPYR	
SMPSON STRONG TIE DTTIZ TENSION TIE AT 4 LOCATIONS	0	AREA: 2131 S.F.
ÉVENLY DISTRIBUTED ALONG DECK AND ONE WITHIN 24" OF EACH END OF LEDGER	ARE	DATE PRINTED:
P.T. 2 X DECK LEDGER	NGS	DRAWN BY: $G.M.B.$
K/JOIST LATERAL CONNECTION	WIN	REVISED:
the same to the same and the same	<	 DI AN NUMBER-

( @ CANTILEVER )

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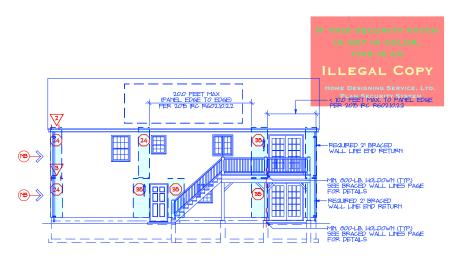


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> RIGHT ELEVATION SCALE: 1/8" = 1-0"

USE PORTAL FRAME OS-PE

FRONT ELEVATION





REAR ELEVATION SCALE: 1/8" = 1-0"

LEFT ELEVATION SCALE 1/8" = 1-0"

BRACED WALL PANELS

### WALL BRACING KEY

### WALL BRACING UPLIFT RESISTANCE


TYPE	DESCRIPTION
1	NO RAFTER BEARING ON THIS PANEL, SO NO UPLIFT RESISTANCE REQUIRED
2	PROVIDE 1 SMPSON STRONG TIE H2A RAFTER TO STUD CONNECTOR AT EACH RAFTER
3	PROVIDE SMPSON STRONG TIE SDWF FLOOR-TO-FLOOR SCREWS AT BASE OF PANEL AT 32" O/C MAX MN 2 CONNECTORS PER PANEL
4	PROVIDE I SIMPSON STRONG, TIE COIL STRAP TE FROM STUD TO BAND JOST, ONE AT EACH EDGE OF BRACED WALL PARIEL MIN 5-8D NALS NTO EACH FRAMING, MEMBER.
5	PROVIDE I SIMPSON STRONG TIE LTP4 TE PLATE FROM BAND JOIST TO SILL PLATE, ONE AT EACH EDGE OF BRACED WALL PANEL IN 6-80 NALS NTO EACH FRAMING MEMBER
6	PROVIDE I SIMPSON STRONG TIE RSP4 STUD PLATE TE FROM STUD TO SILL PLATE, ONE AT EACH EDGE OF BRACED WALL PANEL MI 4-60 NALS NTO EACH FRAMING MEMBER.

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ALE: 1/4"=1'-0"


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# PREZIDED 28 BRACE BLOW SOME THE FOC FILLOR SPAN CONTECTED TO PEC BELOW 2 WALL LINE BY DEFEURN B UPPER LEVEL PLAN SCALE VS + 1-08




### REFER TO HOME DESIGNIG SERVICE, LTD. BRACED WALL CALCULATION WORKSHEET FOR MORE INFORMATION.

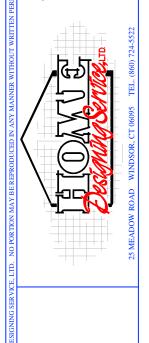

BRACED WALL LINES

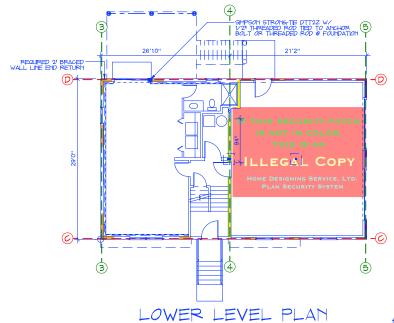SCALE 1/8" = 1/9" W/ BRACED WALL PAPEL LOCATIONS

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SIMPSON STRONG-TIE CONNECTOR NOT TO SCALE

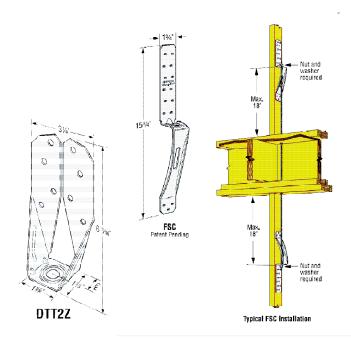25 MEADOW BOAD WINDSON CT GOOD THE (SGO) 774.553

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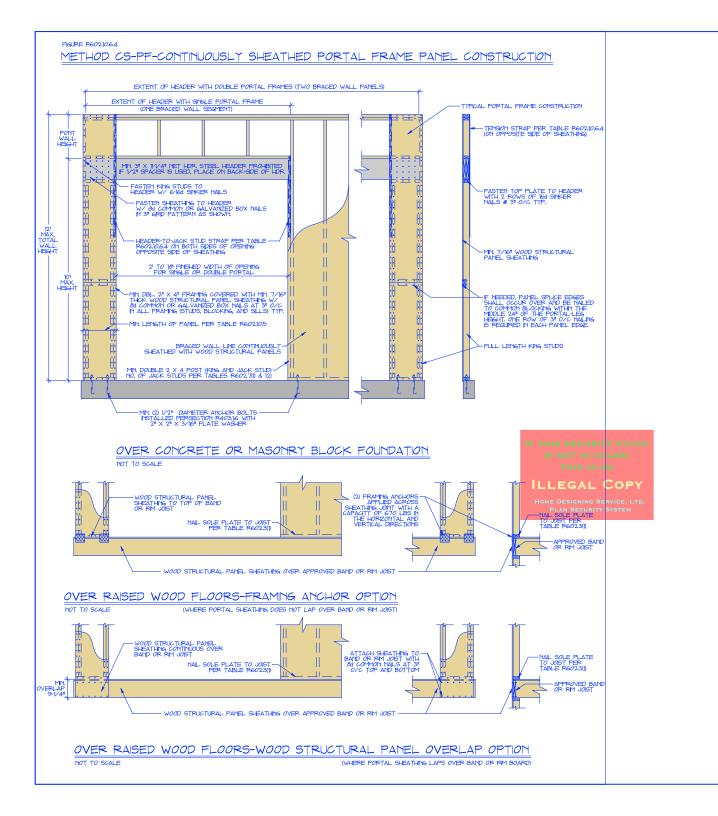
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